







ALL WORK TO COMPLY WITH THE BUILDING CODE OF AUSTRALIA, SAA CODES AND RELEVANT BY-LAWS.

02. DEVELOPMENT APPROVAL

THESE DRAWINGS SHALL BE READ IN CONJUCTION WITH THE DEVELOPMENT APPROVAL ,CONSTRUCTION CERTIFICATE AND ANY SHEDULES ATTACHED THERTO. ALL CONDITIONS MUST BE APPLIED TO THE DEVELOPMENT. WHERE ANY VARIATIONS ARE SOUGHT, IT IS THE RESPONSIBILITY OF THE DEVELOPER TO CONTACT COUNCIL TO OBTAIN APPROVAL FOR ANY SUCH VARIATIONS.

03. ENGINEERING DRAWINGS AND OTHER CONSULTANTS THESE DRAWINGS SHALL BE READ AS A SET AND IN CONJUCTION WITH ALL SPECIFICATIONS, ENGINEERING PLANS AND CONSULTANTS PLANS AS SUPPLIED BY THE DEVELOPER. THESE PLANS AND SPECIFICATIONS MAY INCLUDE BUT ARE NOT LIMITED TO STRUCTURAL PLANS, STORMWATER PLANS ,LANDSCAPE PLANS, HYDRAULIC PLANS, ELECTRICAL DRAWINGS, MECHANICAL VENTILLATION PLANS, FIRE SERVICES PLANS ETC. FINAL COORDINATION OF PLANS BY BUILDER.

04. NATHERS ENERGY EFFICIENCY REPORT/BASIX CERTIFICATE DRAWINGS SHALL BE READ IN CONJUNCTION WITH THE NATHERS



SCALE: 1:200 @ A3

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CHANGE OF USE






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REV:	DESCRIPTION:	DATE:
Α	CDC SUBMISSION	11/07/23

	SUBJECT SITE:	_
	16 David Street, GREENACRE	<i>_</i>
	TITLE: SITE PLAN	_
-	SCALE/SHEET SIZE 1:200 A3 PREPARED: SHEET NO. S-01	_



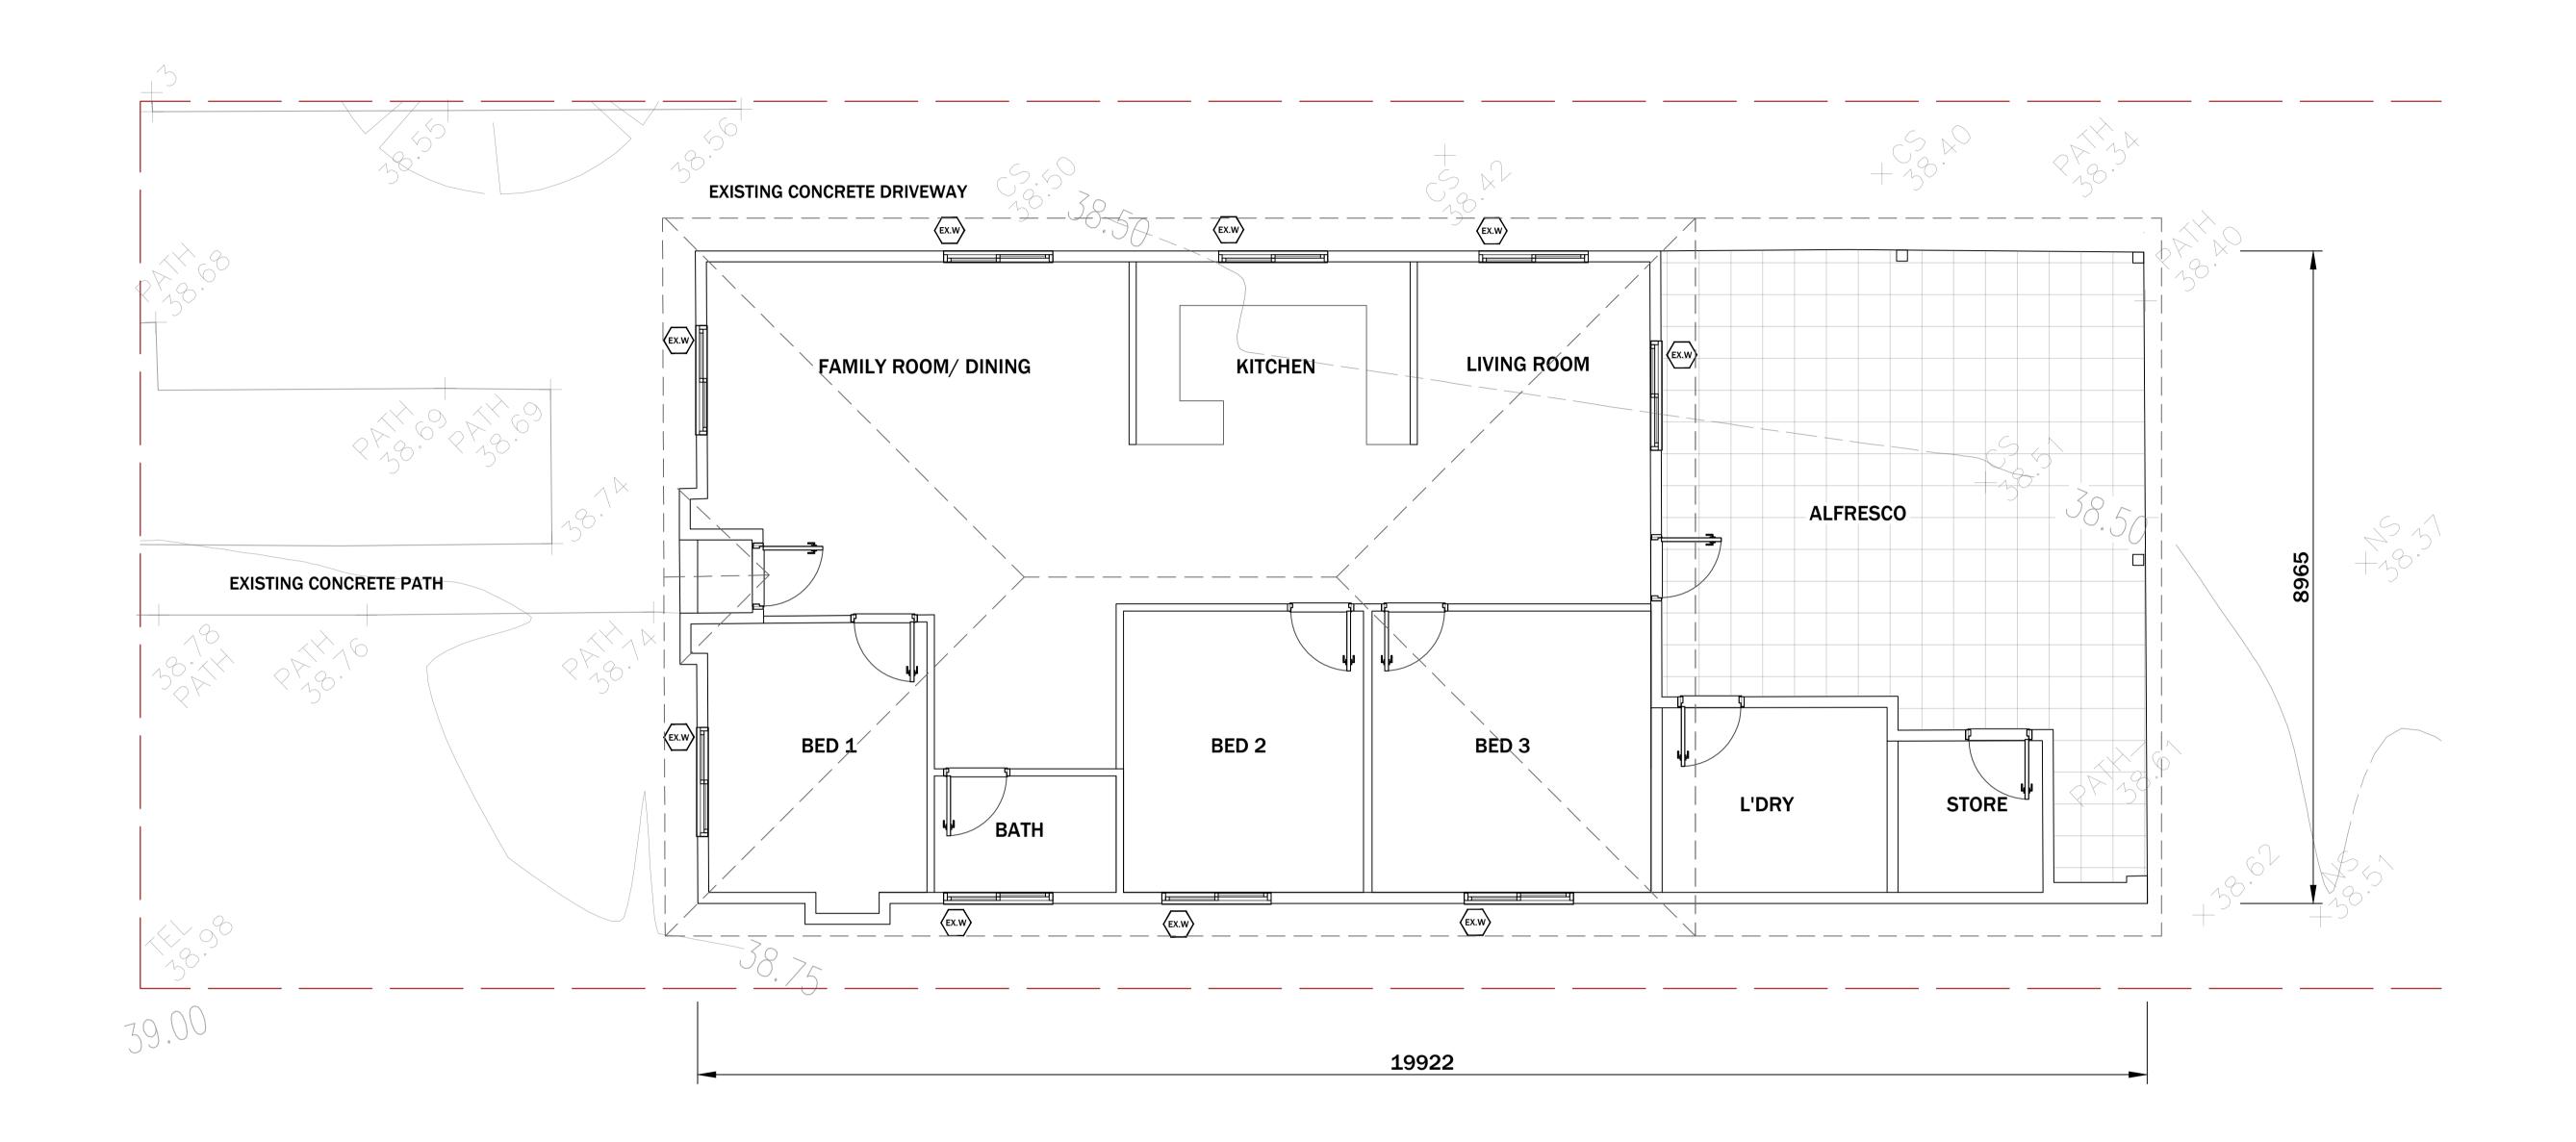

EXISTING GROUND FLOOR PLAN (PRIMARY DWELLING)

SCALE: 1:100 @ A3

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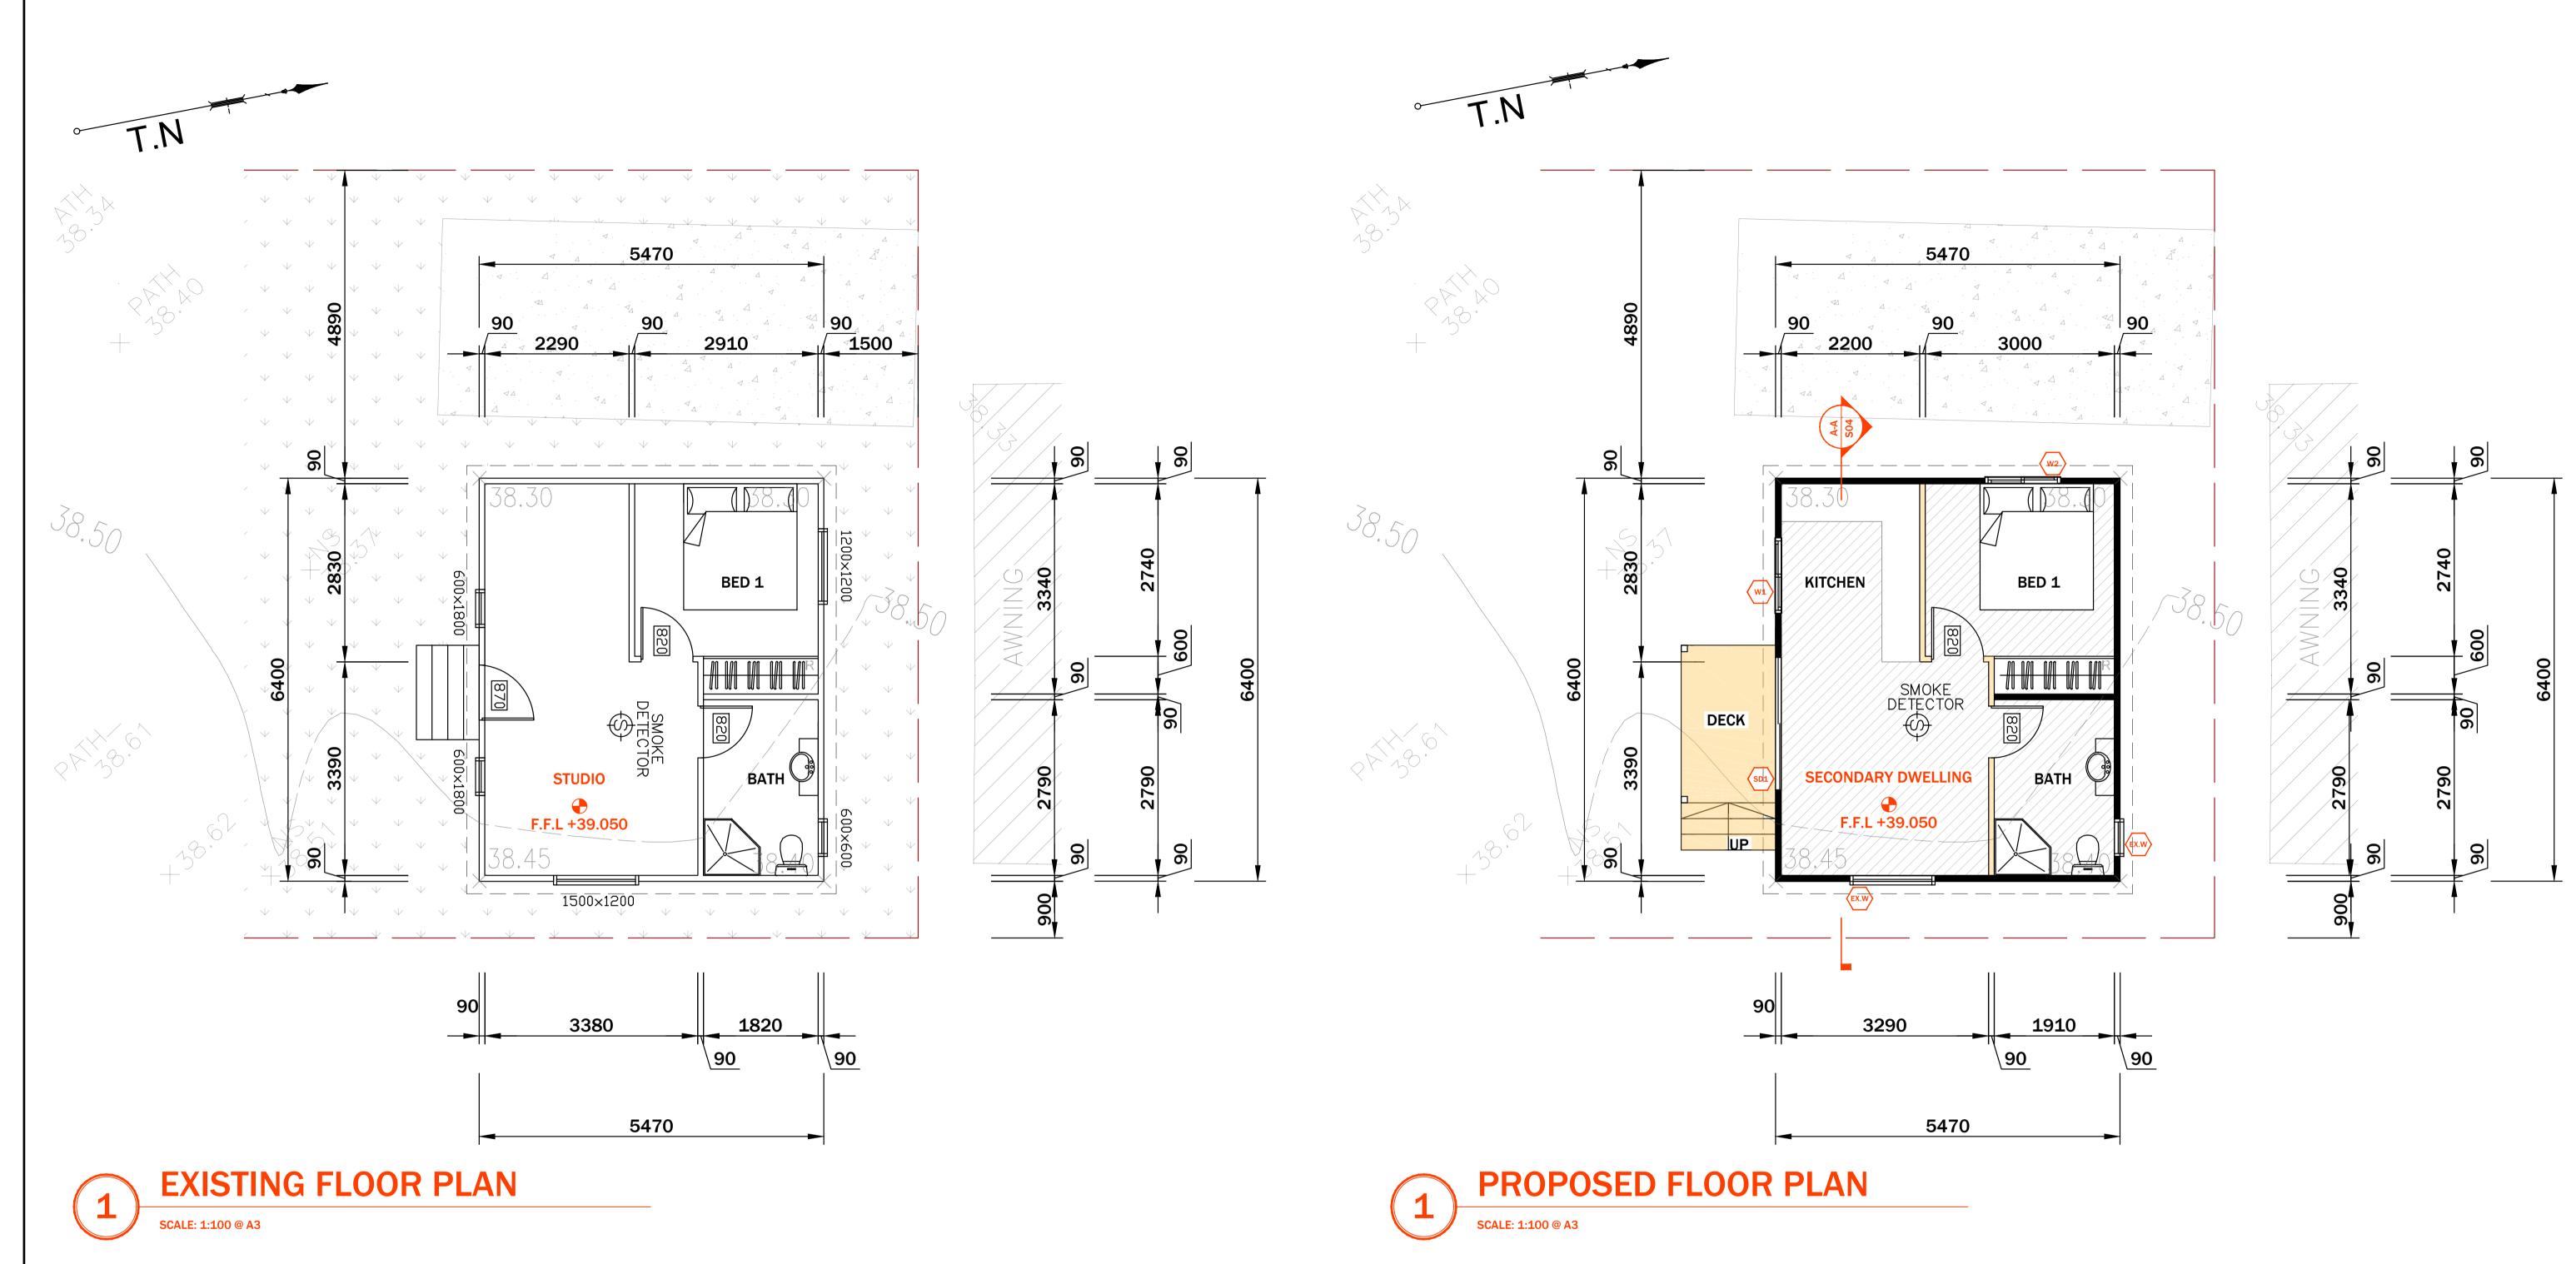
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ASPIRE ENGINEERING
329/462 Chapel Rd,
Bankstown 2200

REV:	DESCRIPTION:	DATE:
Α	DA SUBMISSION	11/07/23
(

SUBJECT SITE: 16 David Street, GREENACRE

TITLE: Existing Floor Plan (Primary Dwelling)

SCALE/SIZE 1:100 A3 PREPARED: SHEET NO. S-02



Maximum floor area for principal and secondary dwelling

- 3.3 Council must not consent to development for the purpose of secondary dwellings unless:
- (a) the total floor area of the principal dwelling and the secondary dwelling is no more than the maximum floor area allowed for a dwelling house on the land under an environmental planning instrument; and
- (b) the total floor area of the secondary dwelling is no more than 60m2 or, if a greater floor area is permitted in respect of a secondary dwelling on the land under an environmental planning instrument, that greater floor area.

MAX. FSR ACCORDING TO BANKSTOWN LEP 2015 - LAND MAPS

PROPOSED FSR - 153 SQM [0.457:1]

CLIENT:

IS 0.5:1 [I.E. 243.45 sqm]

FLOOR AREA OF SECONDARY DWELLING - 33sqm

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WINDOW #

W 1

W 2

DOOR#

SD1

`		REV:	DESCRIPTION:	DATE:
		Α	DA SUBMISSION	11/07/23
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WIDTH

1085

595

WIDTH

2100

PROPOSED WINDOW SCHEDULE

270

570

PROPOSED DOOR SCHEDULE

SLIDING DOOR

2100

HEIGHT


HEIGHT


LEGEND - PROPOSED WALLS/ FLOOR AREA - EXISTING WALLS - EXISTING FLOOR AREA

16 David Street, GREENACRE DRAWING Proposed Floor Plan SCALE/SIZE 1:100 A3 PREPARED: SHEET NO. S-03

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Private open space

3.13 Secondary dwellings must not result in the principal dwelling on the allotment having less than the required landscaped area and private open space.

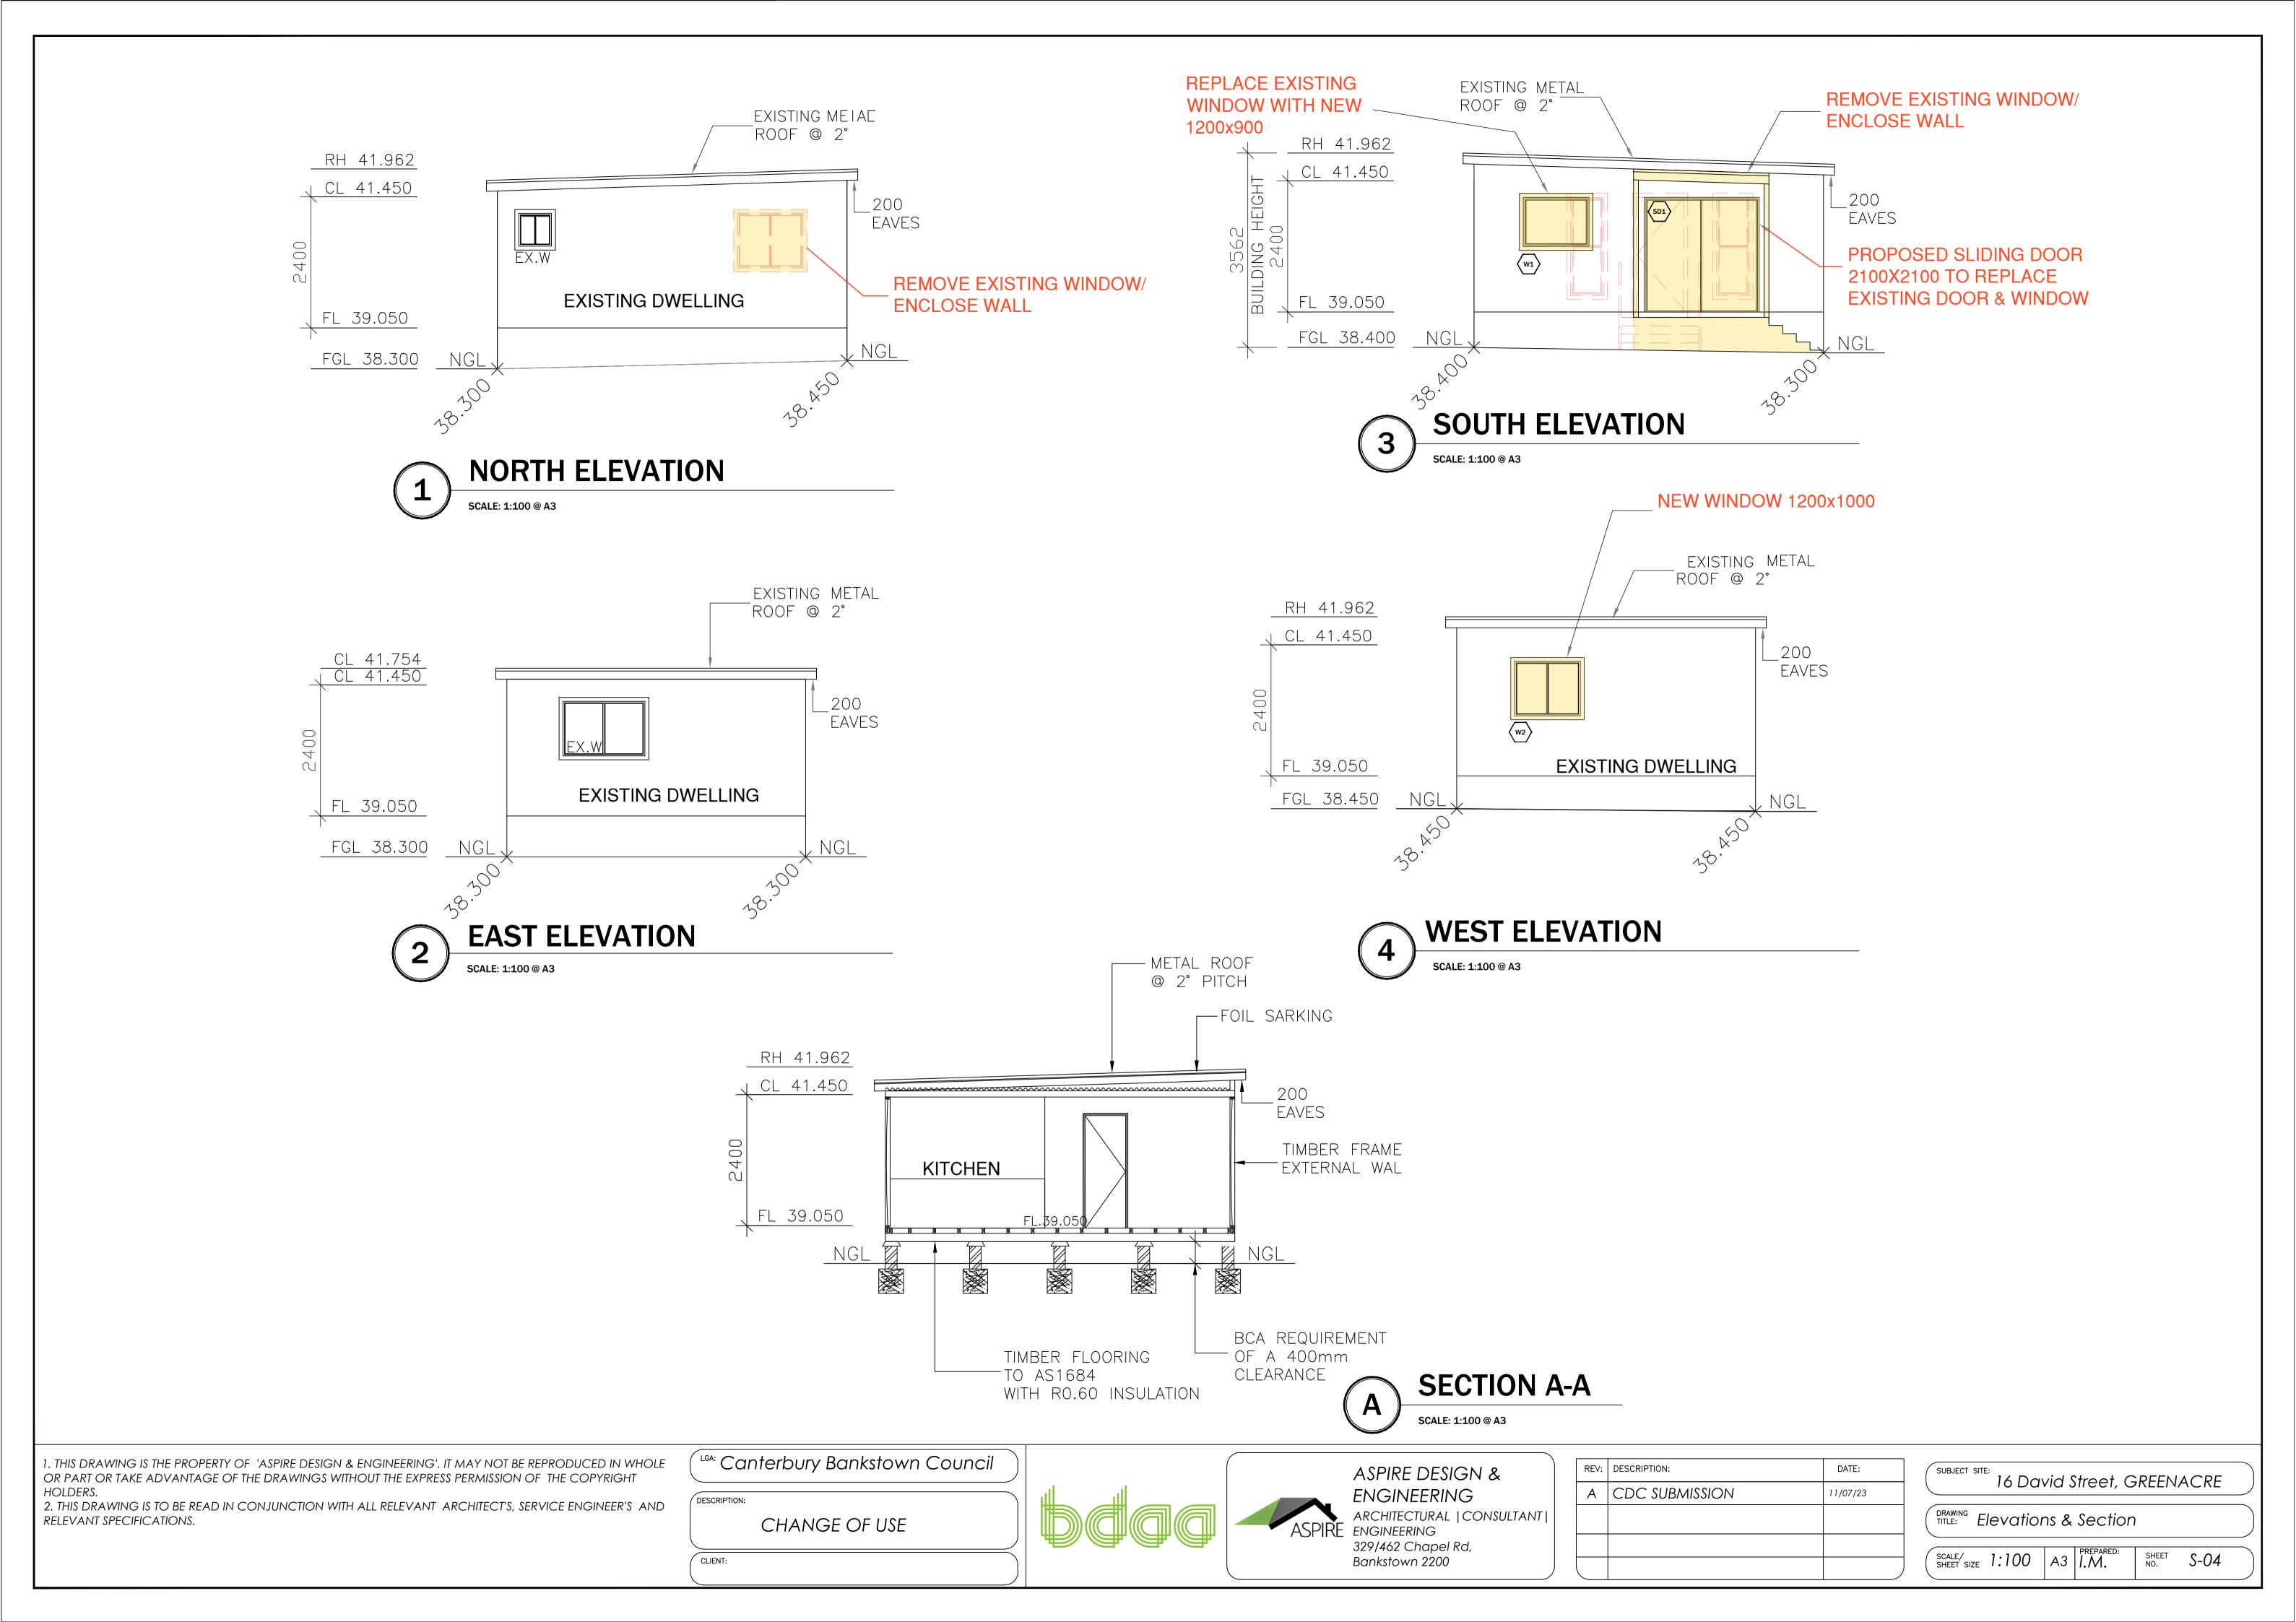Landscaping

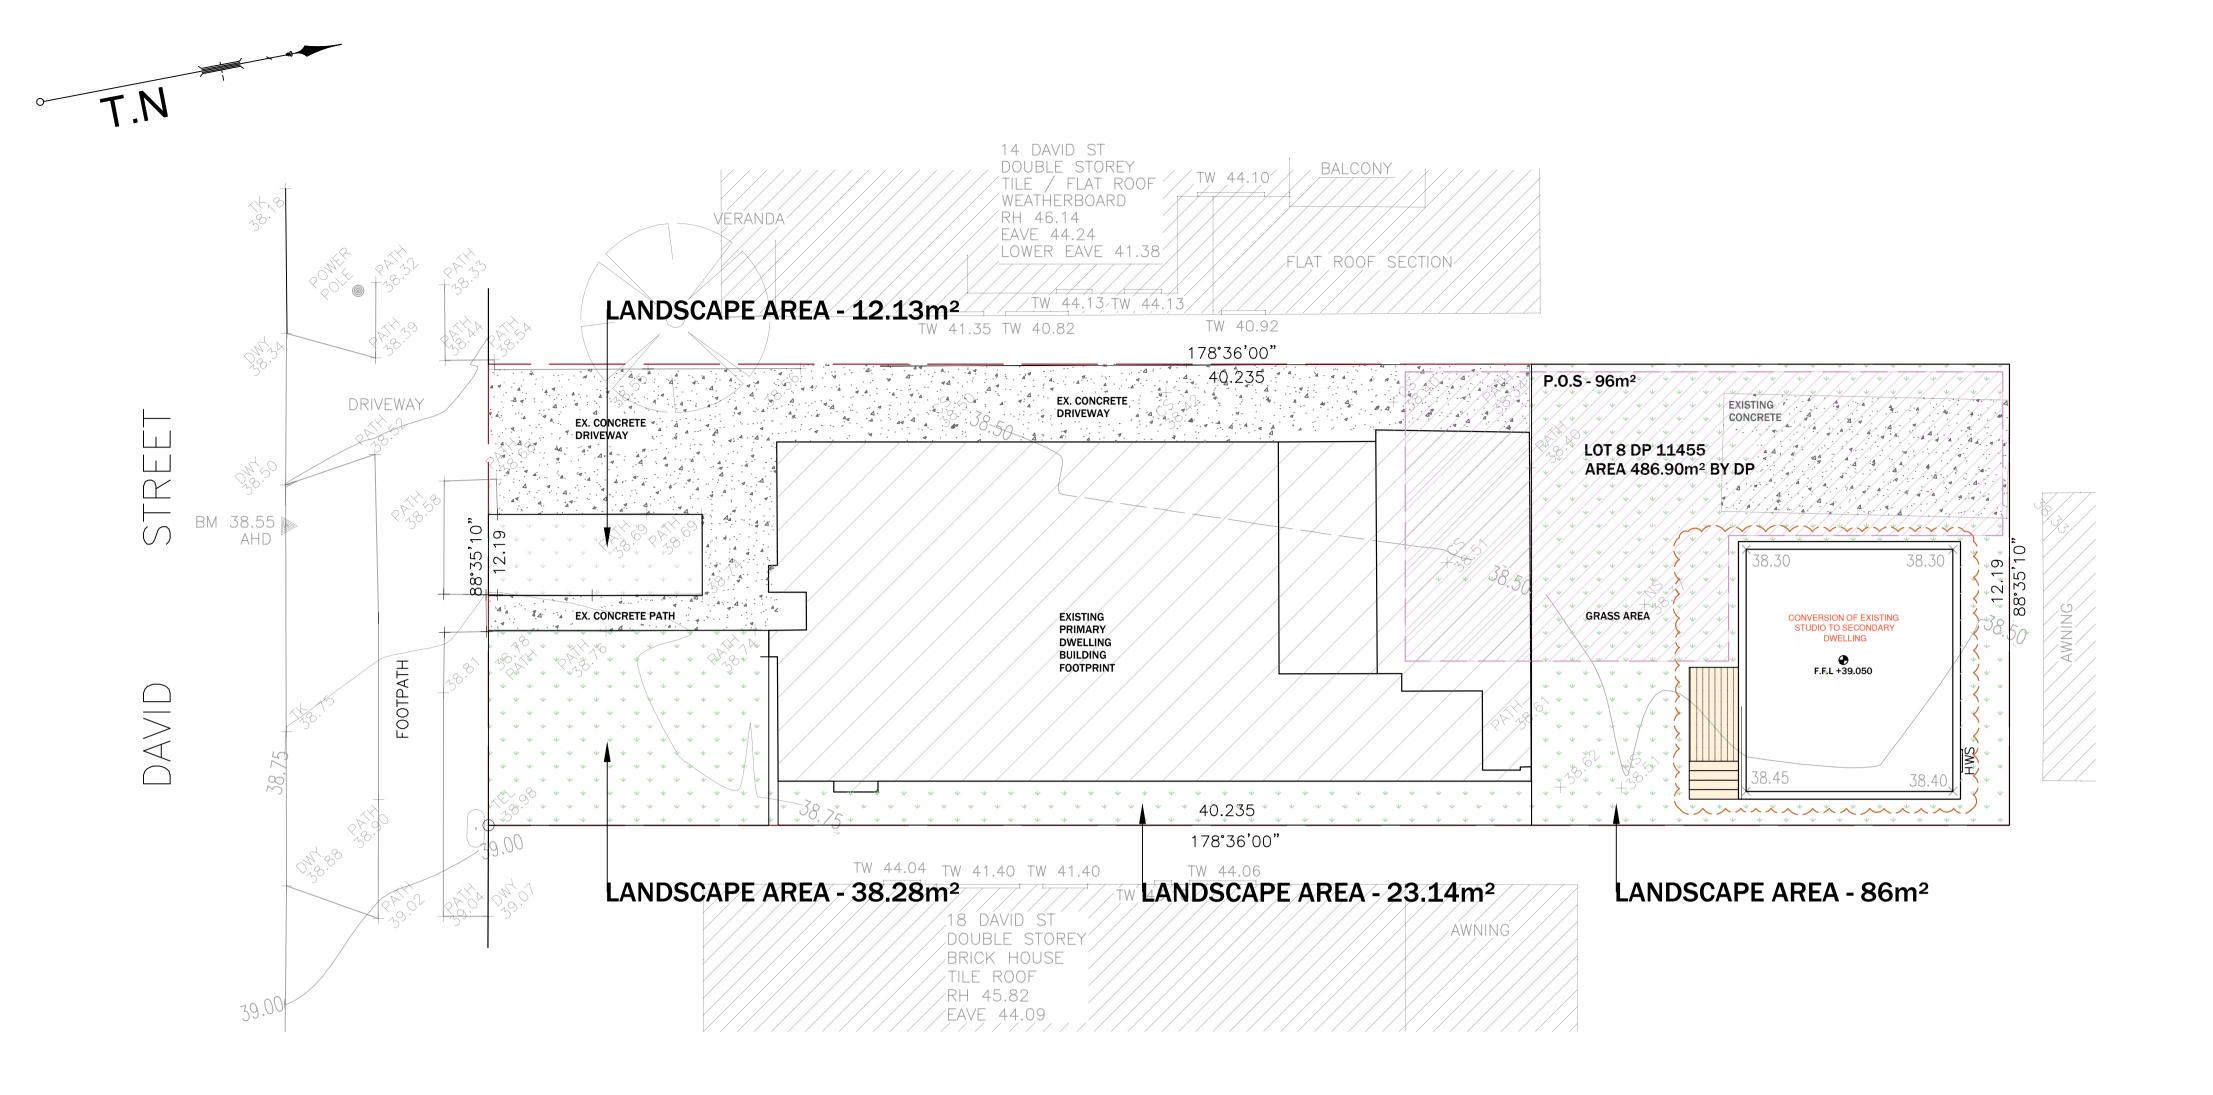3.28 Development must retain and protect any significant trees on the allotment and adjoining allotments. To achieve this clause, the development may require a design alteration or a reduction in the size of the secondary dwelling.


EXISTING PRIVATE OPEN SPACE AREA - 96sqm

MIN. WIDTH OF P.O.S - 5M WIDE

GENERAL NOTES:

- 1/. ALL AREAS WITHIN A DEVELOPMENT NOT OCCUPIED BY BUILDING, DRIVEWAY OR SERVICES AREAS
- THE LANDSCAPED AREA ALSO INCLUDES ANY BALCONY PLANTERS OR LANDSCAPING OVER CONCRETE SLABS. 2/.ALL EXISTING TREES ON THE SITE, ON THE NATURAL STRIP, AND CLOSE TO BOUNDARIES ON NEIGHBORING PROPERTIES
- SHOULD BE ACCURATELY PLOTTED ON PLANS PRESERVED IN ACCORDANCE WITH COUNCIL'S TREE PRESERVATION ORDER.
- 3/.PROTECTIVE FENCING IS TO REMAIN IN PLACE UNTIL COMPLETION OF ALL BUILDING & HARD LANDSCAPE CONSTRUCTION. 4/.CONCRETE PAVING SHOULD BE 20MPA 100MM THICK FOR DRIVEWAYS, & 15MPA 75MM THICK FOR FOOTPATHS, PROVIDED ALL PAVING CONTROL JOINTS AT MAXIMUM 1800MM CENTRES.
- 5/. PAVING LEVELS SHALL BE A MAXIMUM 225MM BELOW SLAB FLOOR LEVELS TO 100MM MINIMUM IN LOCALIZED ARE SUCH AS DOORWAYS, & PROVIDED WITH 1:20 FALLS AWAY FROM THE BUILDING OTHER PAVING SHOULD BE USED WITH LENDING AUTHORITY APPROVAL.
- 6/.PROVIDED METAL, TIMBER OR MASONRY FENCING & GATES TO FRONT BOUNDARY INKEEPING WITH THAT ERECTED IN THE LOCALITY, PROVIDED SIDE & REAR BOUNDARY FENCING TO ENSURE PRIVACY & SAFETY.
- 7/.PROVIDED EXTERNAL LIGHTING FROM THE DWELLING TO ILLUMINATE THE ENTRANCE PATH & FRONT DOOR, REAR DOOR. PROVIDED CLOTHES DRYING LINE WITH PAVING FROM LAUNDRY TO CLOTHER-LINE.
- 8/.PROVIDE A TAP STAND & GULLY TO THE FRONT & REAR OF THE DWELLING WHERE REQUIRED FIXED TO THE EXTERNAL WALL. 9/. ALL LANDSCAPE WORKS ARE TO INCLUDE PROVISION FOR ADEQUATE DRAINAGE INCLUDING COLLECTION OR DISPERSAL OF STORM WATER RUN-OFF, PREVENTION OF PONDING OF WATER ON PAVEMENTS OR DISCHARGE OF RUN-OFF ONTO ADJOINING PROPERTY OR PUBLIC AREAS, WHERE POSSIBLE WATER SHOULD DRAIN TO PLANTING BEDS & LAWN AREAS AS A BASIC WATER CONSERVING STRATEGY.
- 10/.ALL LANDSCAPE CONSTRUCTION BE CARRIED OUT BY A QUALIFIED LANDSCAPE CONTRACTOR TO ENSURE THAT A SATISFACTORY STANDARD OF LANDSCAPING IS ACHIEVED.

LEGEND

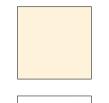

- PROPOSED ALTERATION/ ADDITIONS



- LANDSCAPE AREA



- CONCRETE AREA



- PRIVATE OPEN SPACE

LANDSCAPE PLAN

SCALE: 1:200 @ A3

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REV:	DESCRIPTION:	DATE:
Α	CDC SUBMISSION	11/07/23

SUBJECT S	David Street, GREENACRE	
DRAWING TITLE:	Landscape Plan	

SCALE/ SHEET SIZE 1:200 A3 PREPARED: I.M. SHEET S-05